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Anderson,
Incorporated

Architecture 617-964-1700
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NEEDHAM HIGH SCHOOL


Colby Hall 141 Herrick Road Newton Centre, MA 02459-2218

RENOVATION & ADDITION


Needham, Massachusetts

GRIFFITH & VARY, INC. Consulting Engineers


> 12 Kendrick Road Wareham, MA 02571 508—295—0050 (T) 508—295—0003 (F)

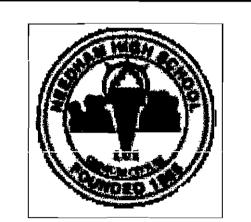

KEYPLAN

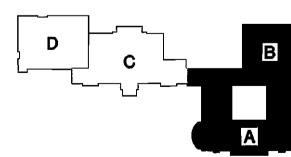

KEY PLAN

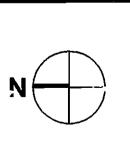


ROOF PLAN AREA "A" & "B" MECHANICAL


Scale: 1/8"-T-0"

Job No.: **03006.0**Drawn By: **JLG**

Date: Oct. 8, 2004

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NOTE: REFER TO SPECIFICATION FOR ADDITIONAL INFORMATION

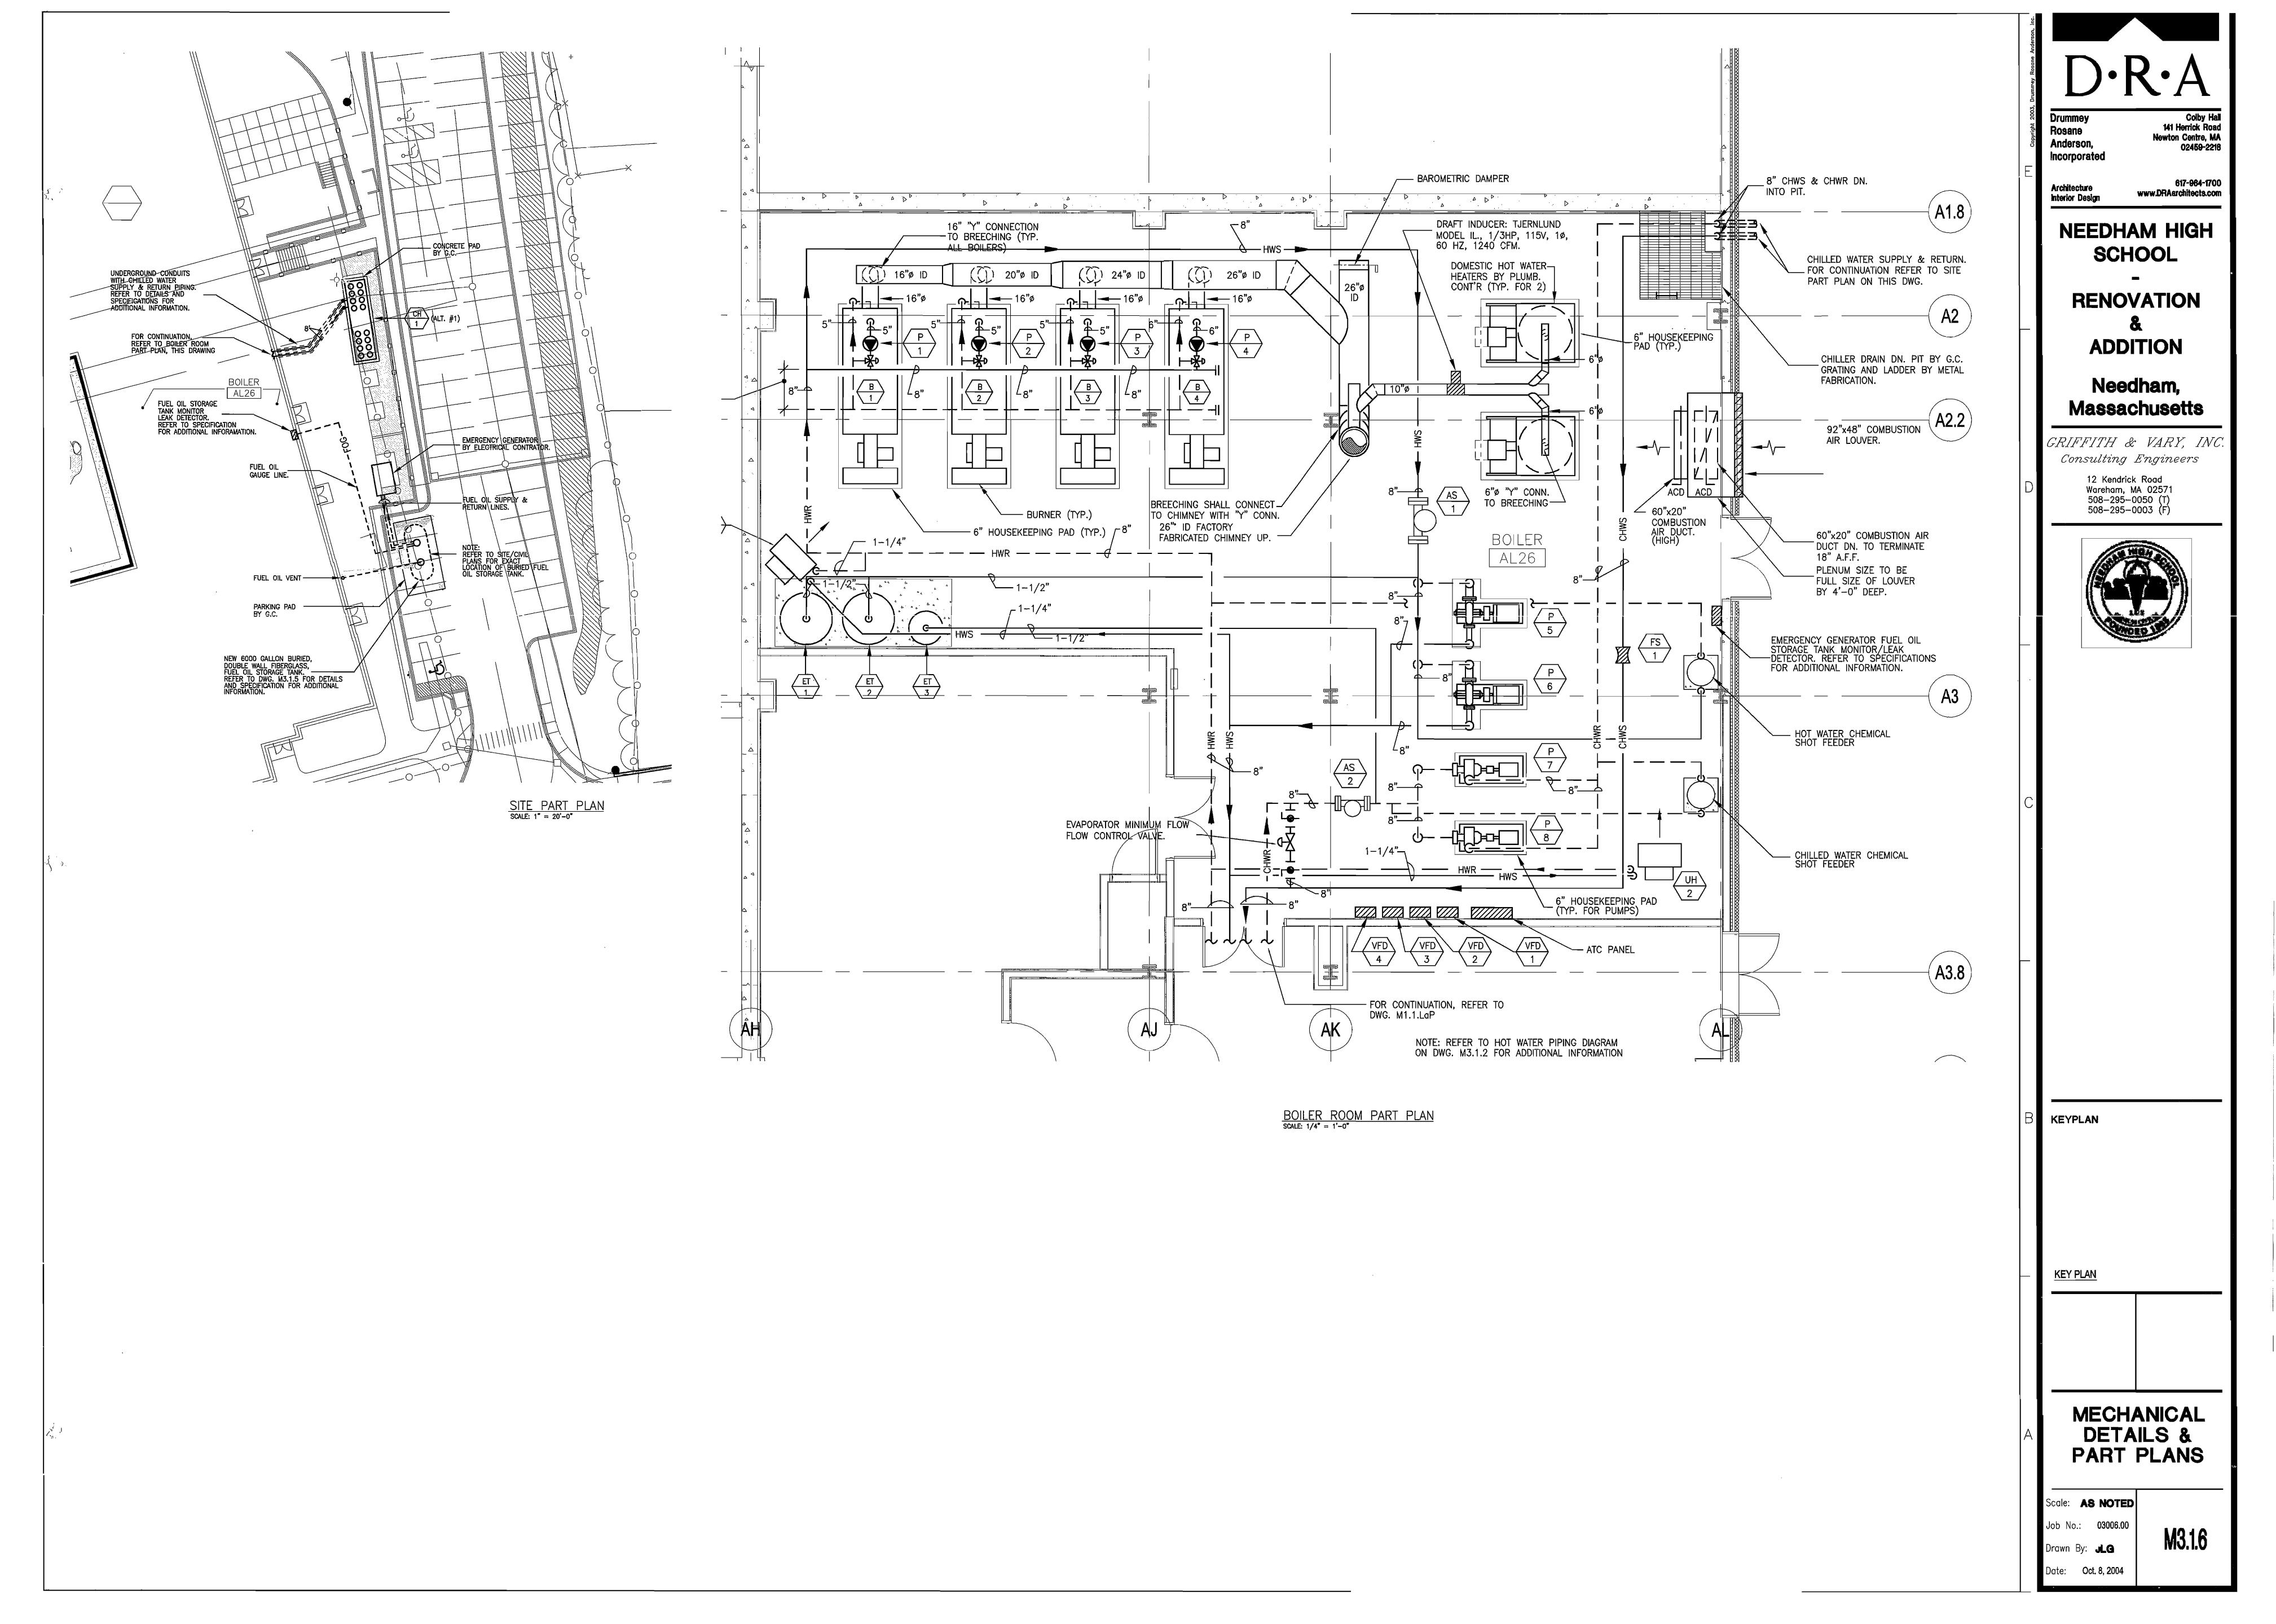- DISCHARGE PLENUM SECTION. DOUBLE CONSTRUCTION WITH 20 GAUGE PERFORATED GALVANIZED STEEL LINER.
- 2 SUPPLY SMOKE DAMPER FURNISHED & INSTALLED BY UNIT MANUFACTURER. SIZE TO MATCH UNIT SUPPLY AIR OPENING. SMOKE DAMPER REQUIRED ON RTU-1,4,5, & 9.
- 3 SUPPLY FAN SECTION. DOUBLE WIDTH,
 DOUBLE INLET, AIRFOIL FAN. FAN SHALL
 BE FURNISHED WITH FAN INLET AIR FLOW STATION
- STRUCTURAL STEEL FAN ISOLATION BASE.
 FAN SHALL BE ISOLATED FROM OUTER
 CASING WITH FACTORY INSTALLED 2"
 DEFLECTION SPRING VIBRATION/SEISMIC
- 5 CHILLED WATER COOLING COIL SECTION. (TYP. FOR RTU-1,4,5,8&12) DX COOLING COIL SECTION (TYP. FOR RTU-2,3,6,7,&9)
- FOR RTU-2,3,6,7,&9)

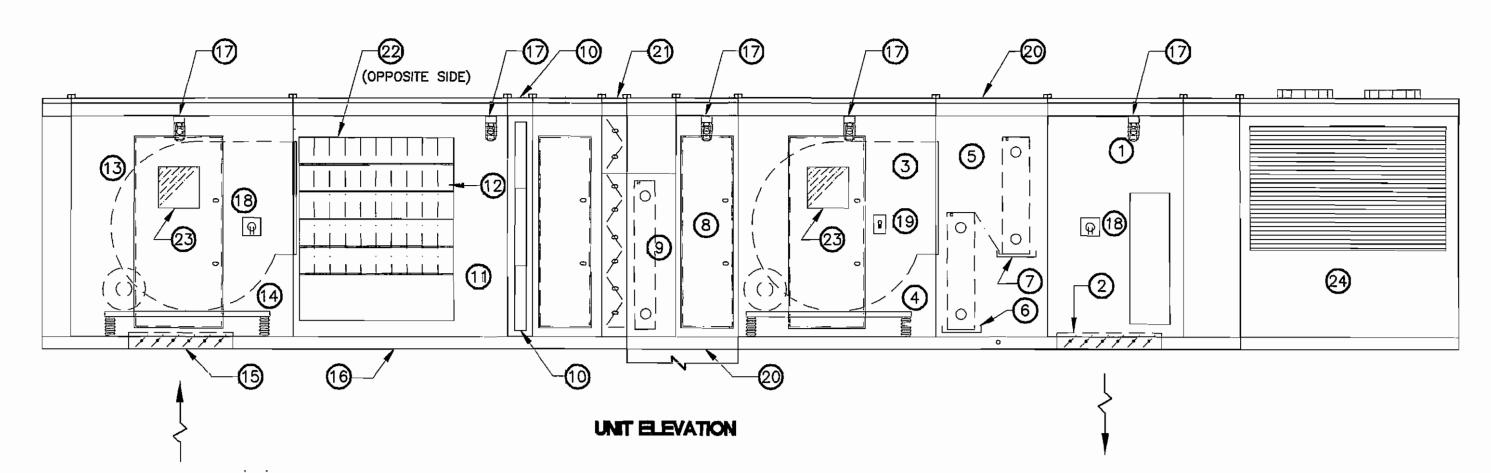
 6 STAINLESS STEEL COOLING COIL DRAIN
- TAINLESS STEEL COOLING COIL
- 8 ACCESS SECTION.
- 9 HOT WATER PREHEAT COIL SECTION.
- 30% EFFICIENCY PRE-FILTERS.
- EXHAUST/MIXING BOX SECTION.
- 2 EXHAUST AIR OUTLET. FRESH AIR INTAKE ON OPPOSITE SIDE OF UNIT.
- RETURN FAN SECTION. REFER TO SCHEDULE FOR FAN TYPE. RETURN FAN SECTION SHALL BE DOUBLE WALL CONSTRUCTION WITH 20 GAUGE PERFORATED GALVANIZED STEEL LINER. FAN SHALL BE FURNISHED WITH FAN INLET AIR FLOW STATION.


- STRUCTURAL STEEL FAN ISOLATION BASE.
 FAN SHALL BE ISOLATED FROM OUTER CASING WITH FACTORY INSTALLED 2" DEFLECTION SPRING VIBRATION/SEISMIC ISOLATORS.
- RETURN SMOKE DAMPER FURNISHED & INSTALLED BY UNIT MANUFACTURER. SIZE TO MATCH UNIT RETURN AIR OPENING. SMOKE DAMPER REQUIRED ON RTU-1,4,5, & 9.
- 16 UNIT BASE RAIL.
- 17 MARINE LIGHT.
- (8) WEATHER PROOF DUPLEX OUTLET.

ACCESS TO VALVES AND PIPING.

- (19) WEATHER PROOF LIGHT SWITCH. ONE SWITCH SHALL CONTROL ALL INTERIOR LIGHTS.
- PIPE VESTIBULE. PIPE VESTIBULE SHALL EXTEND DOWN TO ROOF CURB. PIPE VESTIBULE SHALL ENCLOSE HOT WATER SUPPLY & RETURN PIPING FOR PREHEAT COIL AS WELL AS CHILLED WATER SUPPLY & RETURN PIPING. PIPE VESTIBULE TO BE PROVIDED WITH DOUBLE WALL, INSULATED AND GASKETED DOORS SUITABLE FOR PRACTICAL
- 21 INTERNAL FACE & BYPASS DAMPERS.(EXCLUDING RTU-8)
- FRESH AIR INTAKE WITH RAIN HOOD. FRESH AIR INTAKE SHALL BE FURNISHED WITH MINIMUM OUTSIDE AIR DAMPER WITH INTEGRAL AIR FLOW STATION (RUSKIN AMS-60 OR APPROVED EQUAL) DAMPER SHALL BE SIZED FOR AN AIR VELOCITY OF 1000 FPM.
- 23 VIEW PORT
- integral air cooled condensing unit (RTU-2,3,7,&9).
 RTU-6 SHALL BE FURNISHED WITH SEPARATE AIR COOLED CONDENSING UNIT.
 - NOTE: RTU-1,3,4,5,7,&9 SHALL HAVE VARIABLE FREQUENCY DRIVES FACTORY MOUNTED AND WIRED INSIDE SUPPLY FAN SECTION. RTU-2&6 SHALL HAVE VARIABLE FREQUENCY DRIVES FACTORY MOUNTED AND WIRED INSIDE ACCESS SECTION. RTU-12 SHALL HAVE VARIABLE FRECQUENCY DRIVE FACTORY MOUNTED AND WIRED INSIDE CONTROL ENCLOSURE.

ROOFTOP UNIT DETAIL (TYPICAL FOR RTU-1 THRU 9 & 12)

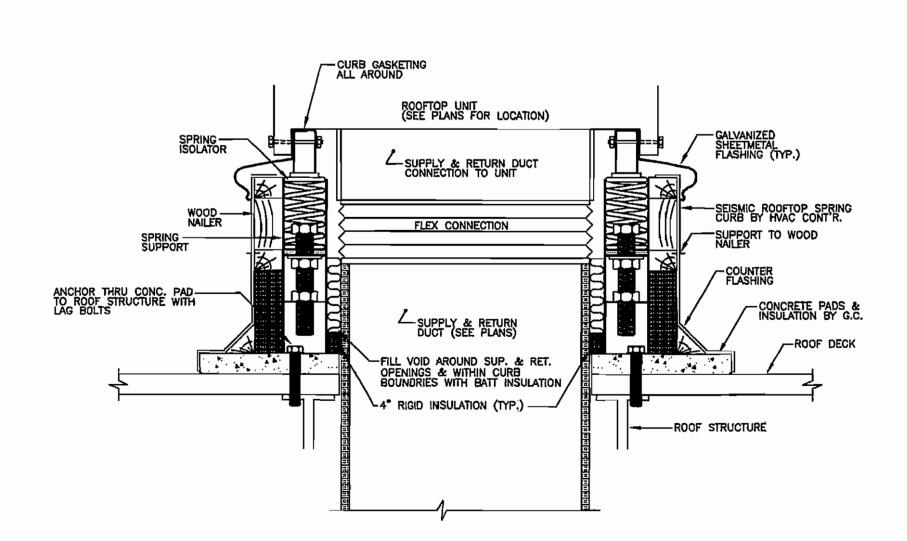

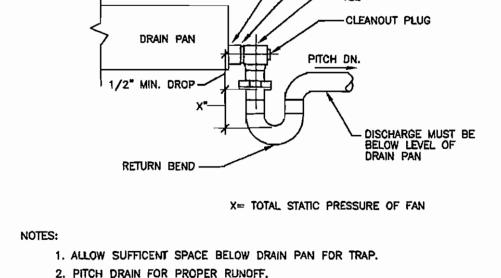


- DRAIN CONNECTION (1-1/4") FPT MIN.

ALLOW SUFFICENT SPACE BELOW DRAIN PAN FOR TRAP.
 PITCH DRAIN FOR PROPER RUNOFF.
 MANUALLY PRIME FILL TRAP BEFORE STARTUP TO FORM INITIAL DRAIN SEAL.
 SUPPORT LENGTHY DRAINS LINES TO PREVENT SAG AND CONDENSATE OVERFLOW.

DRAIN PAN WATER SEAL PIPING DETAIL
NO SCALE

ROOFTOP UNIT CURB DETAIL

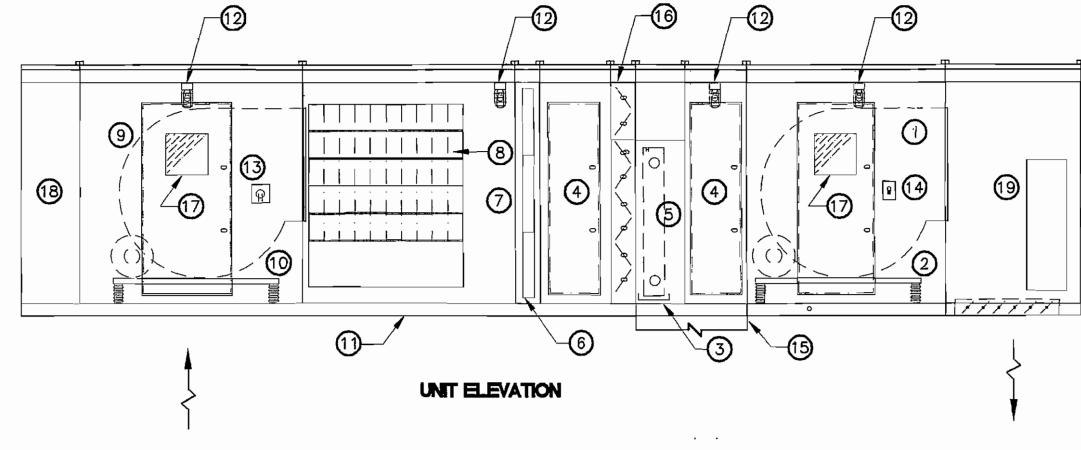


NOTE: REFER TO SPECIFICATION FOR ADDITIONAL INFORMATION

- SUPPLY FAN SECTION. DOUBLE WIDTH, DOUBLE INLET, AIRFOIL FAN.
- 2 STRUCTURAL STEEL FAN ISOLATION BASE. FAN SHALL BE ISOLATED FROM OUTER CASING WITH FACTORY INSTALLED 2" DEFLECTION SPRING VIBRATION/SEISMIC ISOLATORS.
- 3 STAINLESS STEEL COIL DRAIN PAN.
- 4 ACCESS SECTION.
- 5) HOT WATER PREHEAT COIL SECTION.
- 6 30% EFFICIENCY PRE-FILTERS.
- EXHAUST/MIXING BOX SECTION.
- 8 EXHAUST AIR OUTLET. FRESH AIR INTAKE ON OPPOSITE SIDE OF UNIT.
- 9 RETURN FAN SECTION. DOUBLE WIDTH,
 DOUBLE INLET, AIRFOIL FAN. RETURN
 FAN SECTION SHALL BE DOUBLE WALL
 CONSTRUCTION WITH 20 GAUGE PERFORATED
 GALVANIZED STEEL LINER. (EXCLUDING RTU-10 & 13)

- STRUCTURAL STEEL FAN ISOLATION BASE.
 FAN SHALL BE ISOLATED FROM OUTER CASING
 WITH FACTORY INSTALLED 2" DEFLECTION
 SPRING VIBRATION/SEISMIC ISOLATORS.
- 11 UNIT BASE RAIL.
- 12 MARINE LIGHT.
- (13) WEATHER PROOF DUPLEX OUTLET.
- WEATHER PROOF LIGHT SWITCH. ONE SWITCH SHALL CONTROL ALL INTERIOR LIGHTS.
- PIPE VESTIBULE. PIPE VESTIBULE SHALL EXTEND DOWN TO ROOF CURB. PIPE VESTIBULE SHALL ENCLOSE HOT WATER SUPPLY & RETURN PIPING FOR PREHEAT COIL. PIPE VESTIBULE TO BE PROVIDED WITH DOUBLE WALL, INSULATED AND GASKETED DOORS SUITABLE FOR PRACTICAL ACCESS TO VALVES AND PIPING.
- (6) INTERNAL FACE & BYPASS DAMPERS
- 17) VIEW PORT
- (18) CONTROL ENCLOSURE
- DISCHARGE PLENUM SECTION. DOUBLE CONSTRUCTION WITH 20 GAUGE PERFORATED GALVANIZED STEEL LINER.

ROOFTOP UNIT DETAIL (TYPICAL FOR RTU-10, 11 & 13)
NO SCALE

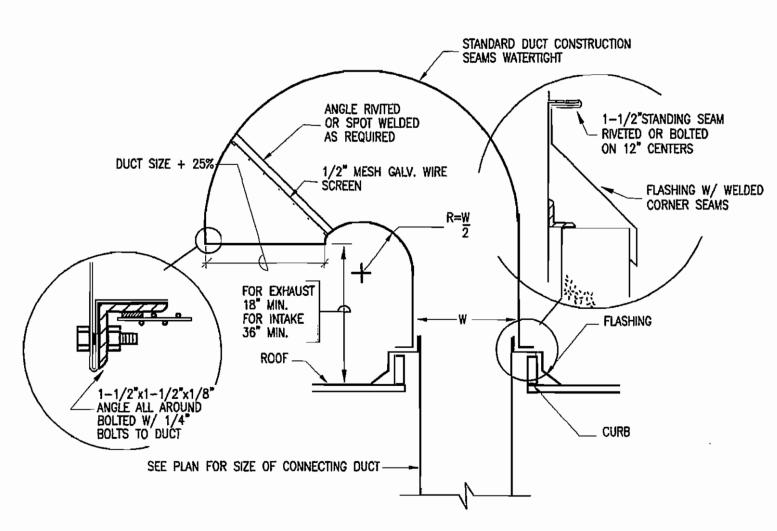


- NOTES:

 1. SEE ARCHITECTURAL DRAWINGS &/OR SPECIFACATIONS FOR CURB, FLASHING & ROOFING
- 2. WHEN WOOD PLATE IS PROVIDED AROUND TOP OF CURB, SECURE FLASHING & GOOSENECK TO WOOD PLATE WITH 3/8" CADMIUM PLATED LAG BOLTS NOT OVER 12" ON CENTERS
- WHEN PREFAB. METAL CURB IS USED, SECURE FLASHING & GOOSENECK WITH SHEET METAL SCREWS AS REQUIRED FOR TIGHT JOINTS & RIGID INSULATION

RECTANGULAR GOOSENECK DETAIL

NO SCALE

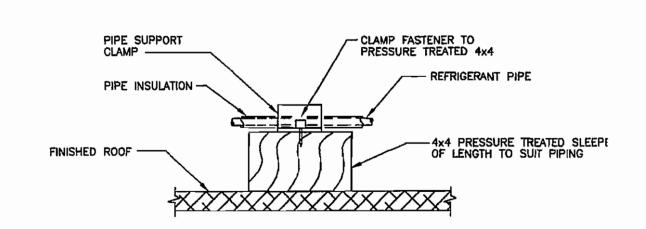

REFRIGERANT PIPING SUPPORT DETAIL

WI DEIME

MECHANICAL DETAILS

Scale: AS NOTED

o No.: **03006.00** own By: **KN**

Date: Oct. 8, 2004

SCHOOL -RENOVATION &

141 Herrick Road

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Needham, Massachusetts

ADDITION

NEEDHAM HIGH

Rosane


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Drummey Rosane Anderson,

Newton Centre, MA 02459-2218 incorporated Architecture

Interior Design **NEEDHAM HIGH**

Colby Hall 141 Herrick Road

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SCHOOL

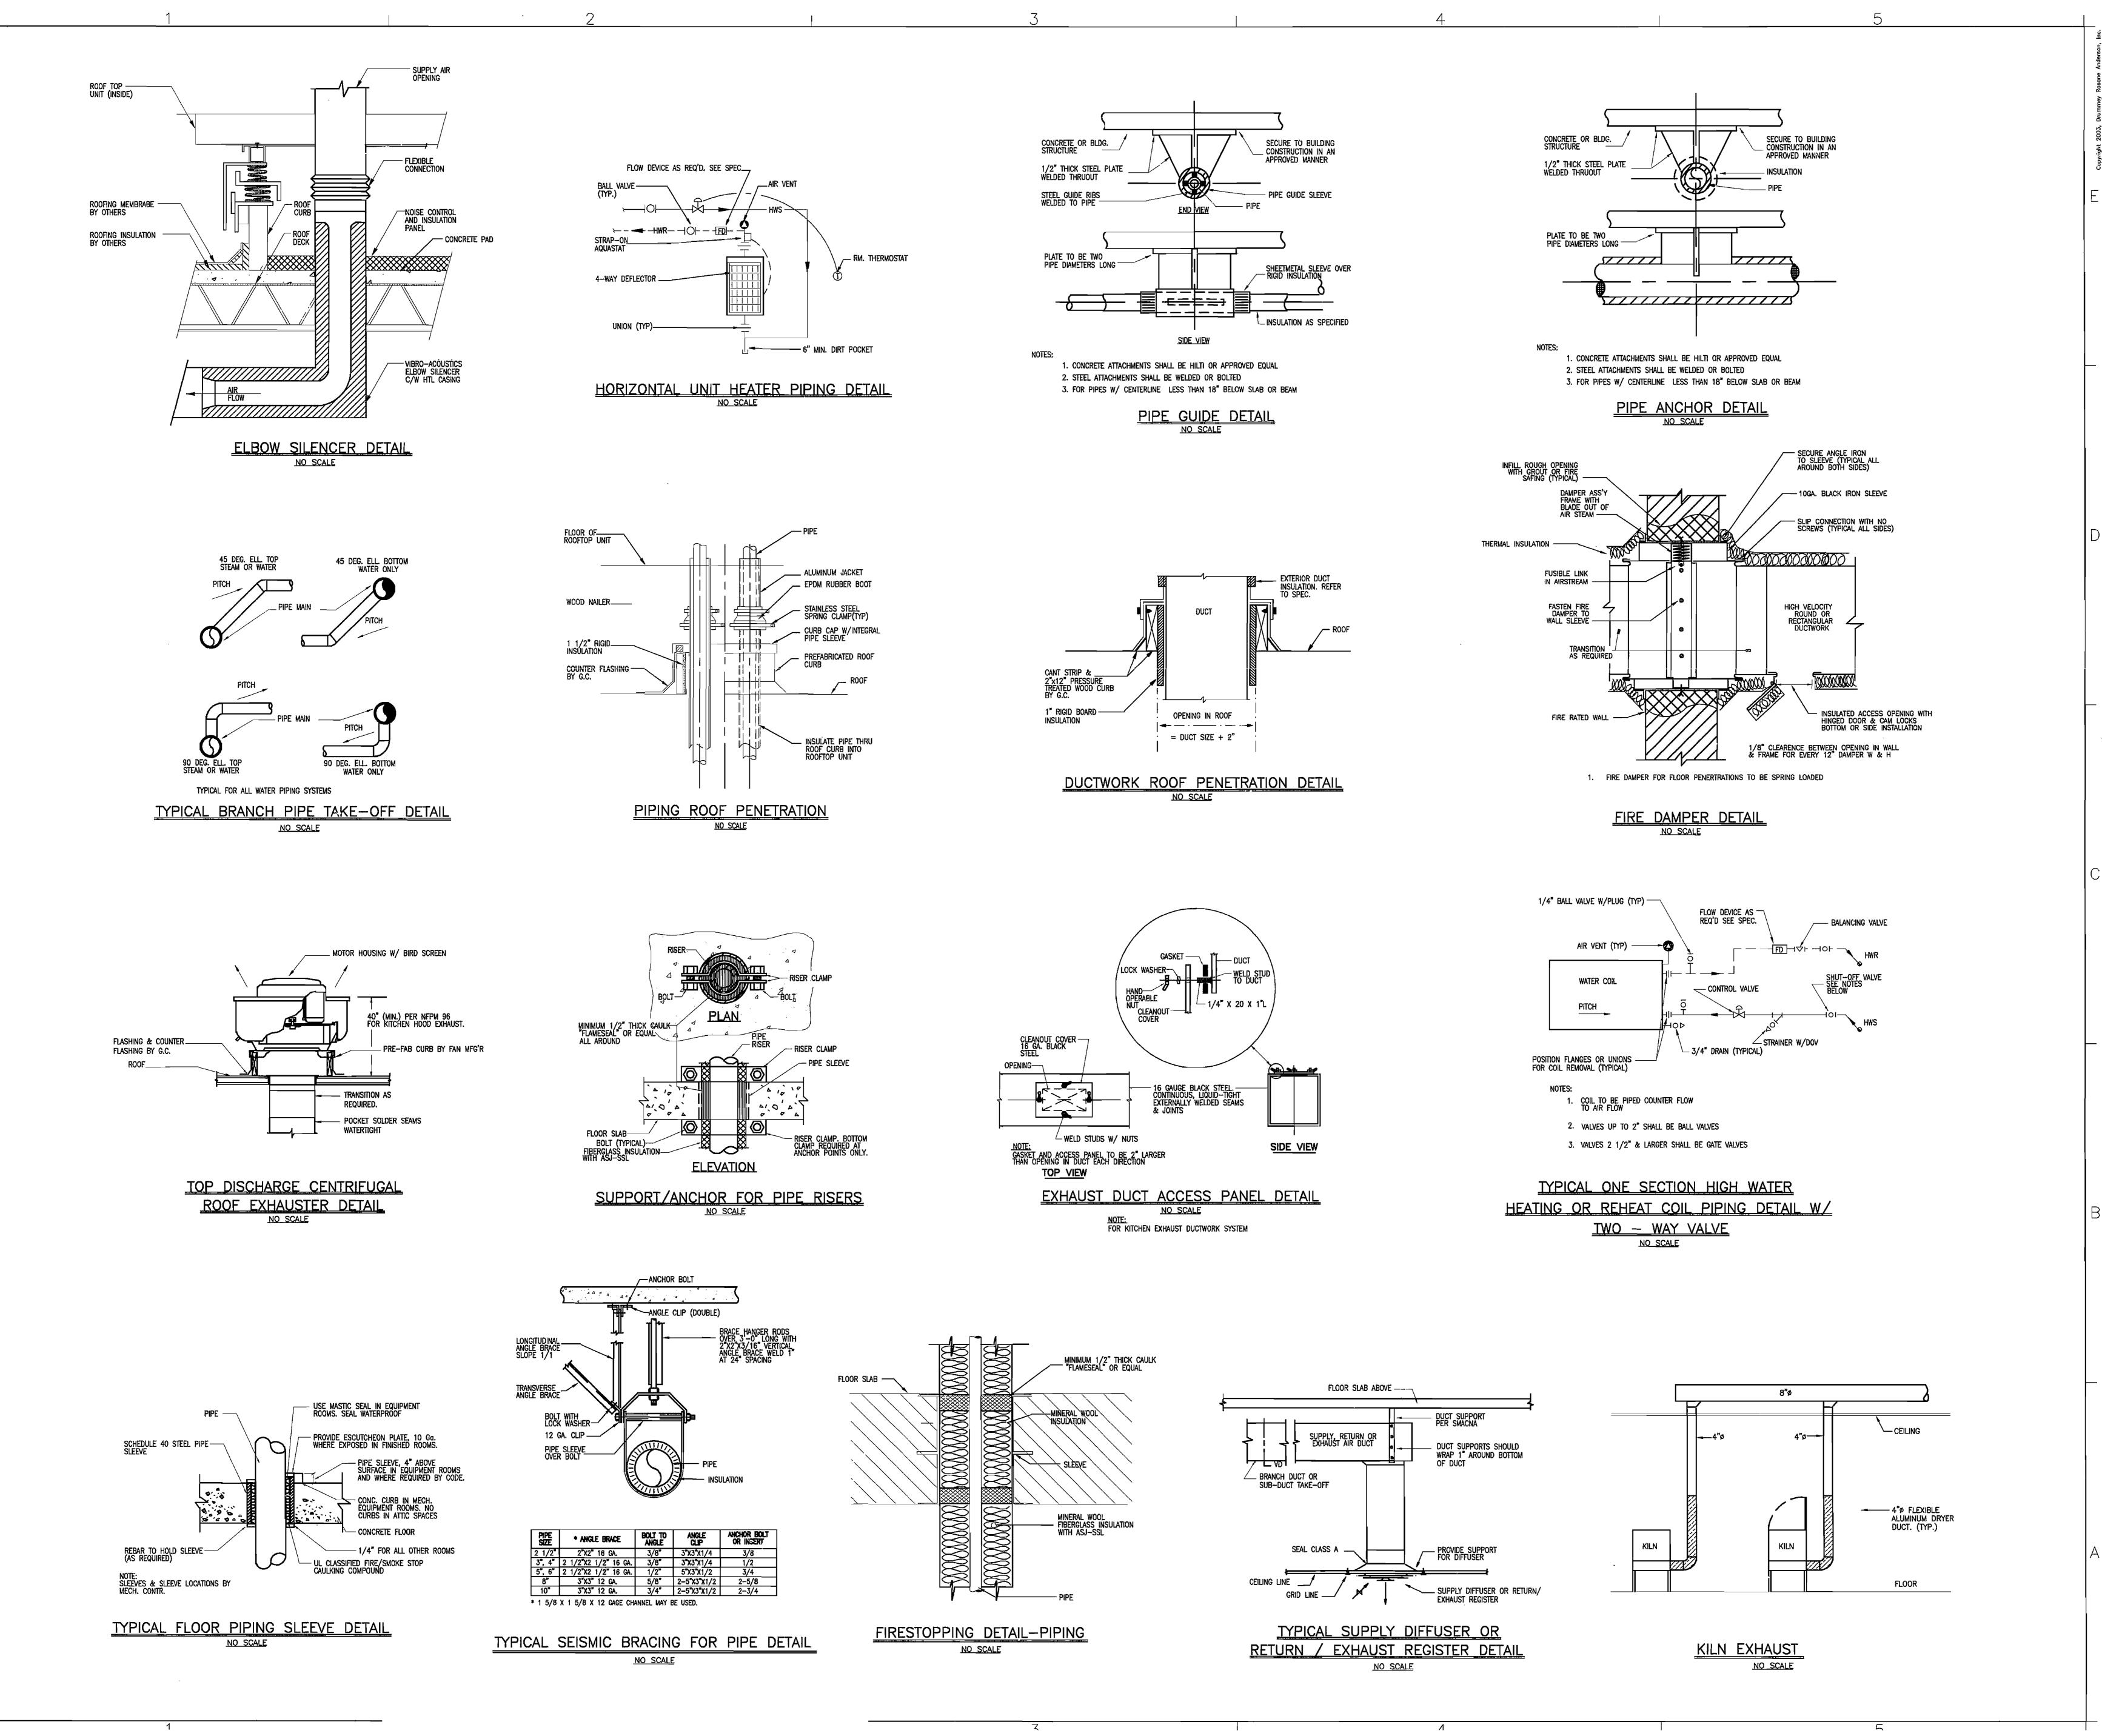ADDITION

Needham, Massachusetts

GRIFFITH & VARY, INC Consulting Engineers 12 Kendrick Road Wareham, MA 02571

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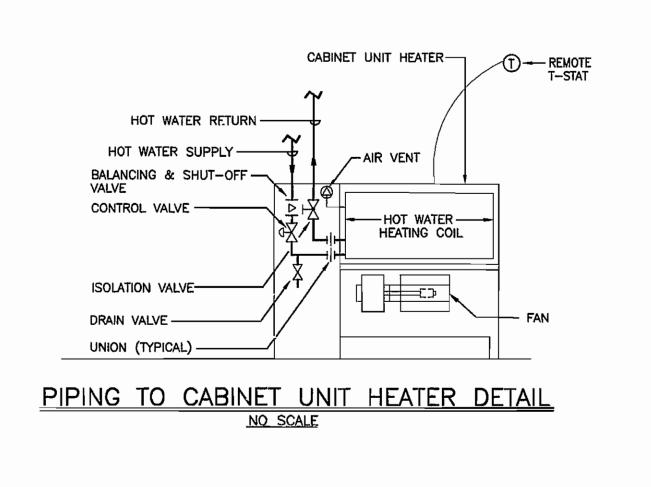



MECHANICAL DETAILS

Scale: AS NOTED Job No.: 03006.00 Drawn By: KN

Date: Oct. 8, 2004

M3.1.3




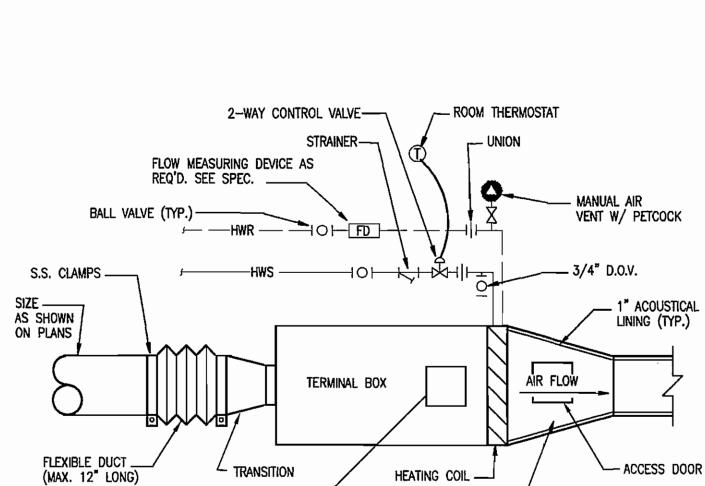

ACCESS DOOR


(BY UNIT MFG'R)

VARIABLE AIR VOLUME OR CONSTANT VOLUME TERMINAL BOX WITH HEATING COIL DETAIL NO SCALE

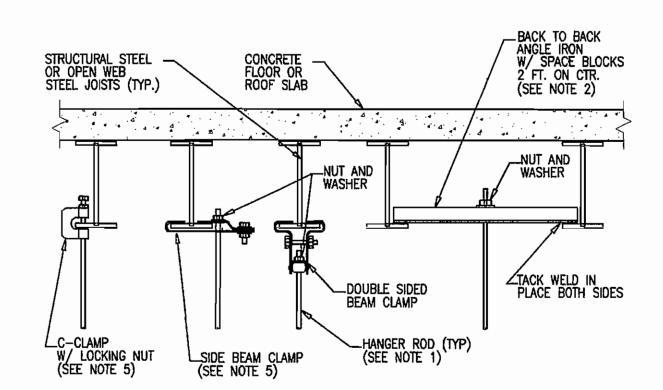


- 1. REFER TO PIPE HANGER DETAIL FOR HANGER ROD SIZE. FOR CEILING SUSPENDED EQUIPMENT PROVIDE MIN. 3/8" DIA. HANGER ROD (REFER TO MANUFACTURERS INSTALLATION INSTRUCTIONS).
- 2. FOR PIPES UNDER 2" USE A SINGLE 1-1/2"x1-1/2"x1/4" ANGLE IRON WITH C-CLAMP. FOR PIPES 2-1/2" AND LARGER USE 3"x3"x1/4" ANGLE IRON BACK TO BACK AS SHOWN. 3. REFER TO "TYPICAL METHOD OF SECURING HANGER RODS TO CONCRETE DECK DETAIL" FOR ATTACHING HANGER RODS TO CONCRETE DECK.
- REPAIR OF FIREPROOFING IN ORDER TO FACILLITATE THE INSTALLATION OF HANGER RODS IN EXISTING CONSTRUCTION SHALL BE BY THE G.C.
 USE OF C-CLAMPS AND SIDE BEAM CLAMPS IS LIMITED TO PIPING 2-1/2" AND UNDER.


TYPICAL METHODS OF SECURING HANGER RODS TO STRUCTURL STEEL DETAIL

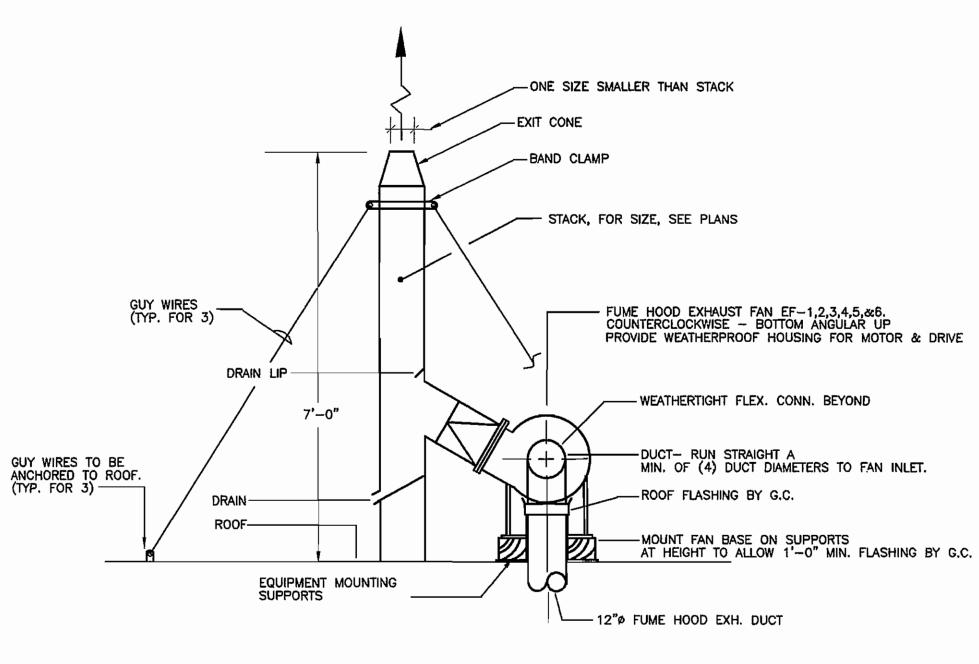


OFFSET STACK DETAIL - FUME HOOD EXHAUST SYSTEM

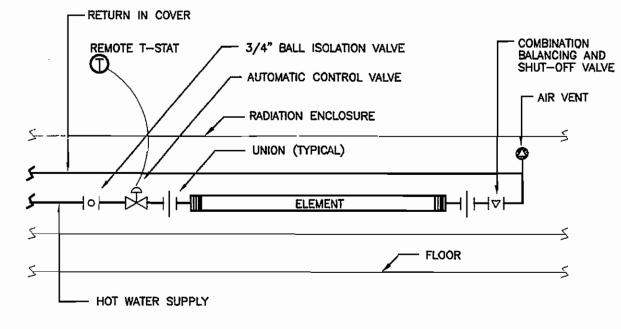


RETURN IN COVER RADIATION PIPING DETAIL NO SCALE

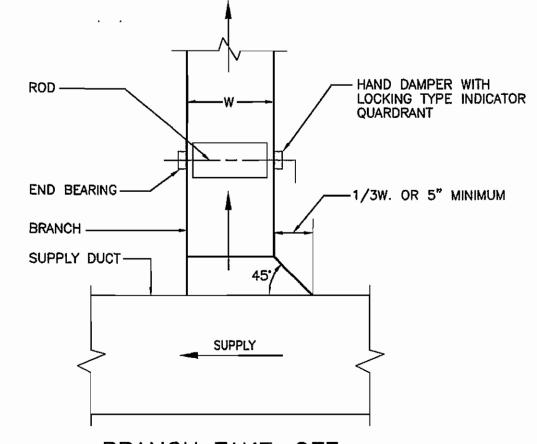

BRANCH TAKE-OFF W/VOLUME DAMPER DETAIL NO SCALE

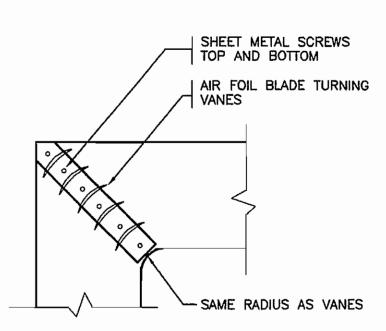


SQUARE ELBOW DETAIL NO SCALE

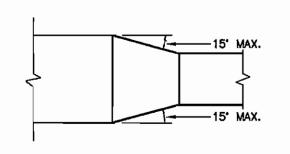


PLAN OR SIDE VIEW


DUCT TRANSITION DETAIL

NO SCALE

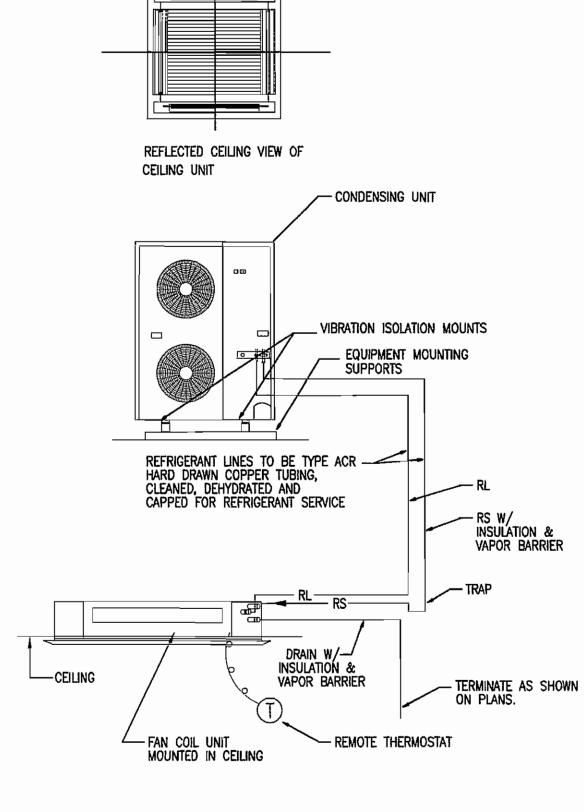

DUCTLESS FAN COIL AIR CONDITIONING UNIT & PIPING DETAIL
NO SCALE

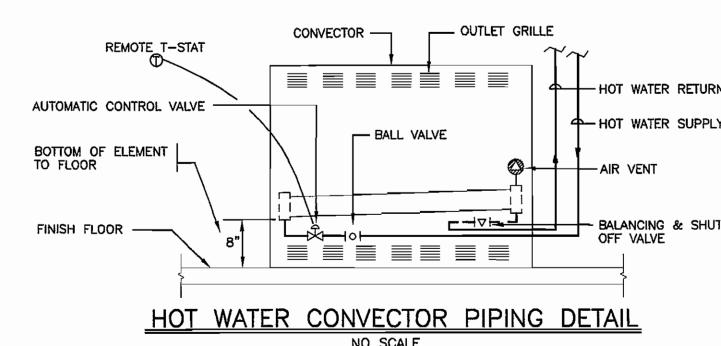

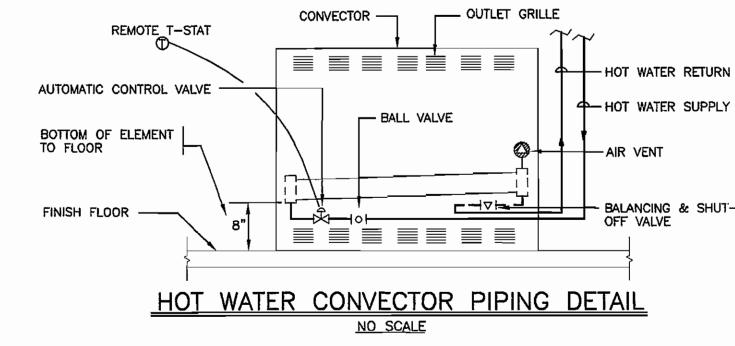

_LOCKING NUT AND WASHER

HIGH DENSITY
INSULATION 12" LONG

HANGER ROD SPACING

PIPE SADDLE (SEE NOTE 2)

1. REFER TO "TYPICAL METHOD OF SECURING HANGER RODS DETAIL" FOR ATTACHING HANGERS TO THE STRUCTURE.

2. PROVIDE INSULATION SHIELD OR PIPE SADDLE BASED ON THE PIPING SYSTEM AND PIPE SIZE AS INDICATED IN THE SPECIFICATIONS.

3. ADJUSTABLE YOKE PIPE ROLL SHALL BE USED ON 4" AND 5" PIPING. ON ALL PIPING 6" AND LARGER USE DUAL ROD PIPE ROLL.

PIPE ROLL TYPE PIPE HANGER

INSTALLATION DETAIL

NO SCALE

HANGER ROD SCHEDULE

SHUTOFF VALVE,


PRESSURE GAGE -(TYPICAL)

FLEXIBLE CONNECTOR (TYP.) — SEE SPECIFICATIONS


SEE SPECIFICATIONS

SERVICE CLEARANCE FOR STRAINER REMOVAL
SUCTION DIFFUSER - SEE SPECIFICATIONS

ADJUSTABLE SUPPORT-

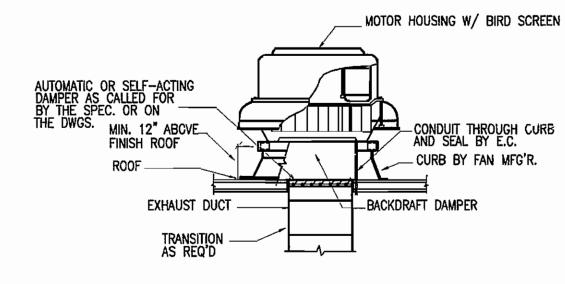


CENTRIFUGAL ROOF EXHAUSTER DETAIL WITH PREFABRICATED CURB NO SCALE

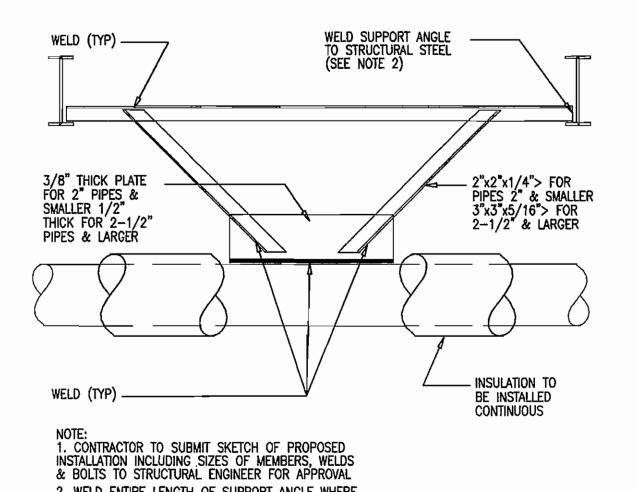

PIPE HANGER DETAIL STRUCTURAL STEEL NO SCALE

2. WELD ENTIRE LENGTH OF SUPPORT ANGLE WHERE SUPPORT ANGLE IS RUN PARALLEL TO STRUCTURAL

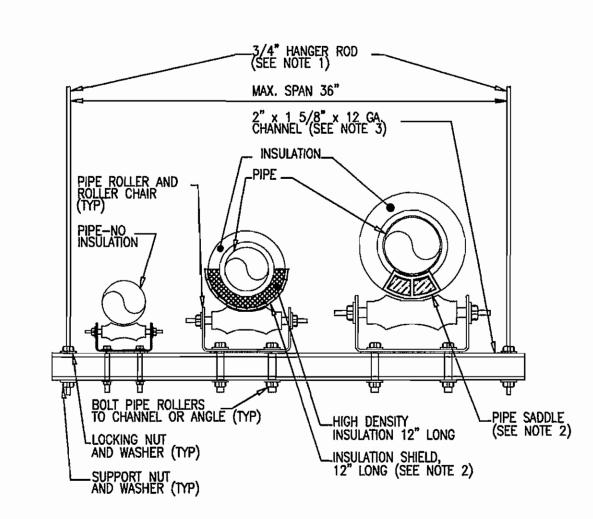


1. REFER TO "TYPICAL METHOD OF SECURING HANGER RODS DETAIL" FOR ATTACHING HANGERS TO THE STRUCTURE. 2. PROVIDE INSULATION SHIELD OR PIPE SADDLE BASED ON THE PIPING SYSTEM AND PIPE SIZE AS INDICATED IN THE SPECIFICATIONS.

3. TRAPEZE TYPE HANGER SHALL BE USED FOR A MAXIMUM 1000 LB. UNIFORM LOAD.

TRAPEZE TYPE PIPE HANGER INSTALLATION DETAIL
NO SCALE

NO SCALE

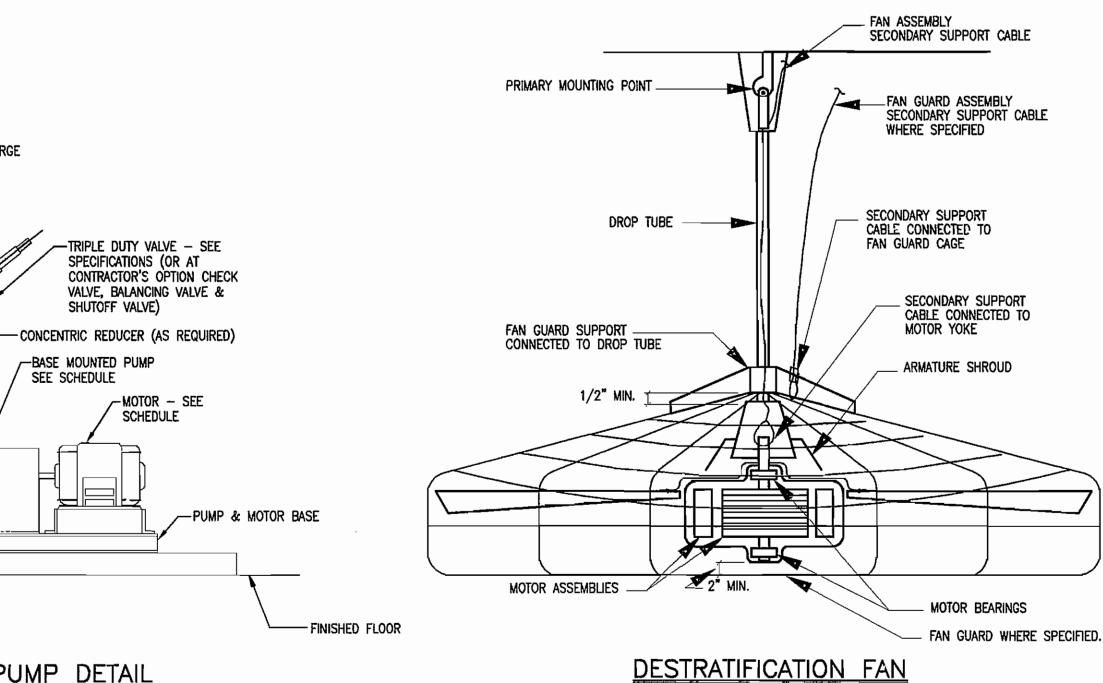

END SUCTION PUMP DETAIL

NO SCALE

Colby Hall 141 Herrick Road Drummey Rosane **Newton Centre, MA** Anderson, 02459-2216 Incorporated

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SCHOOL

Interior Design **NEEDHAM HIGH**

RENOVATION ADDITION

Needham, Massachusetts

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MECHANICAL DETAILS

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M3.1.1